



1 FRONT ELEVATION  
A2.0 1/4" = 1'-0"

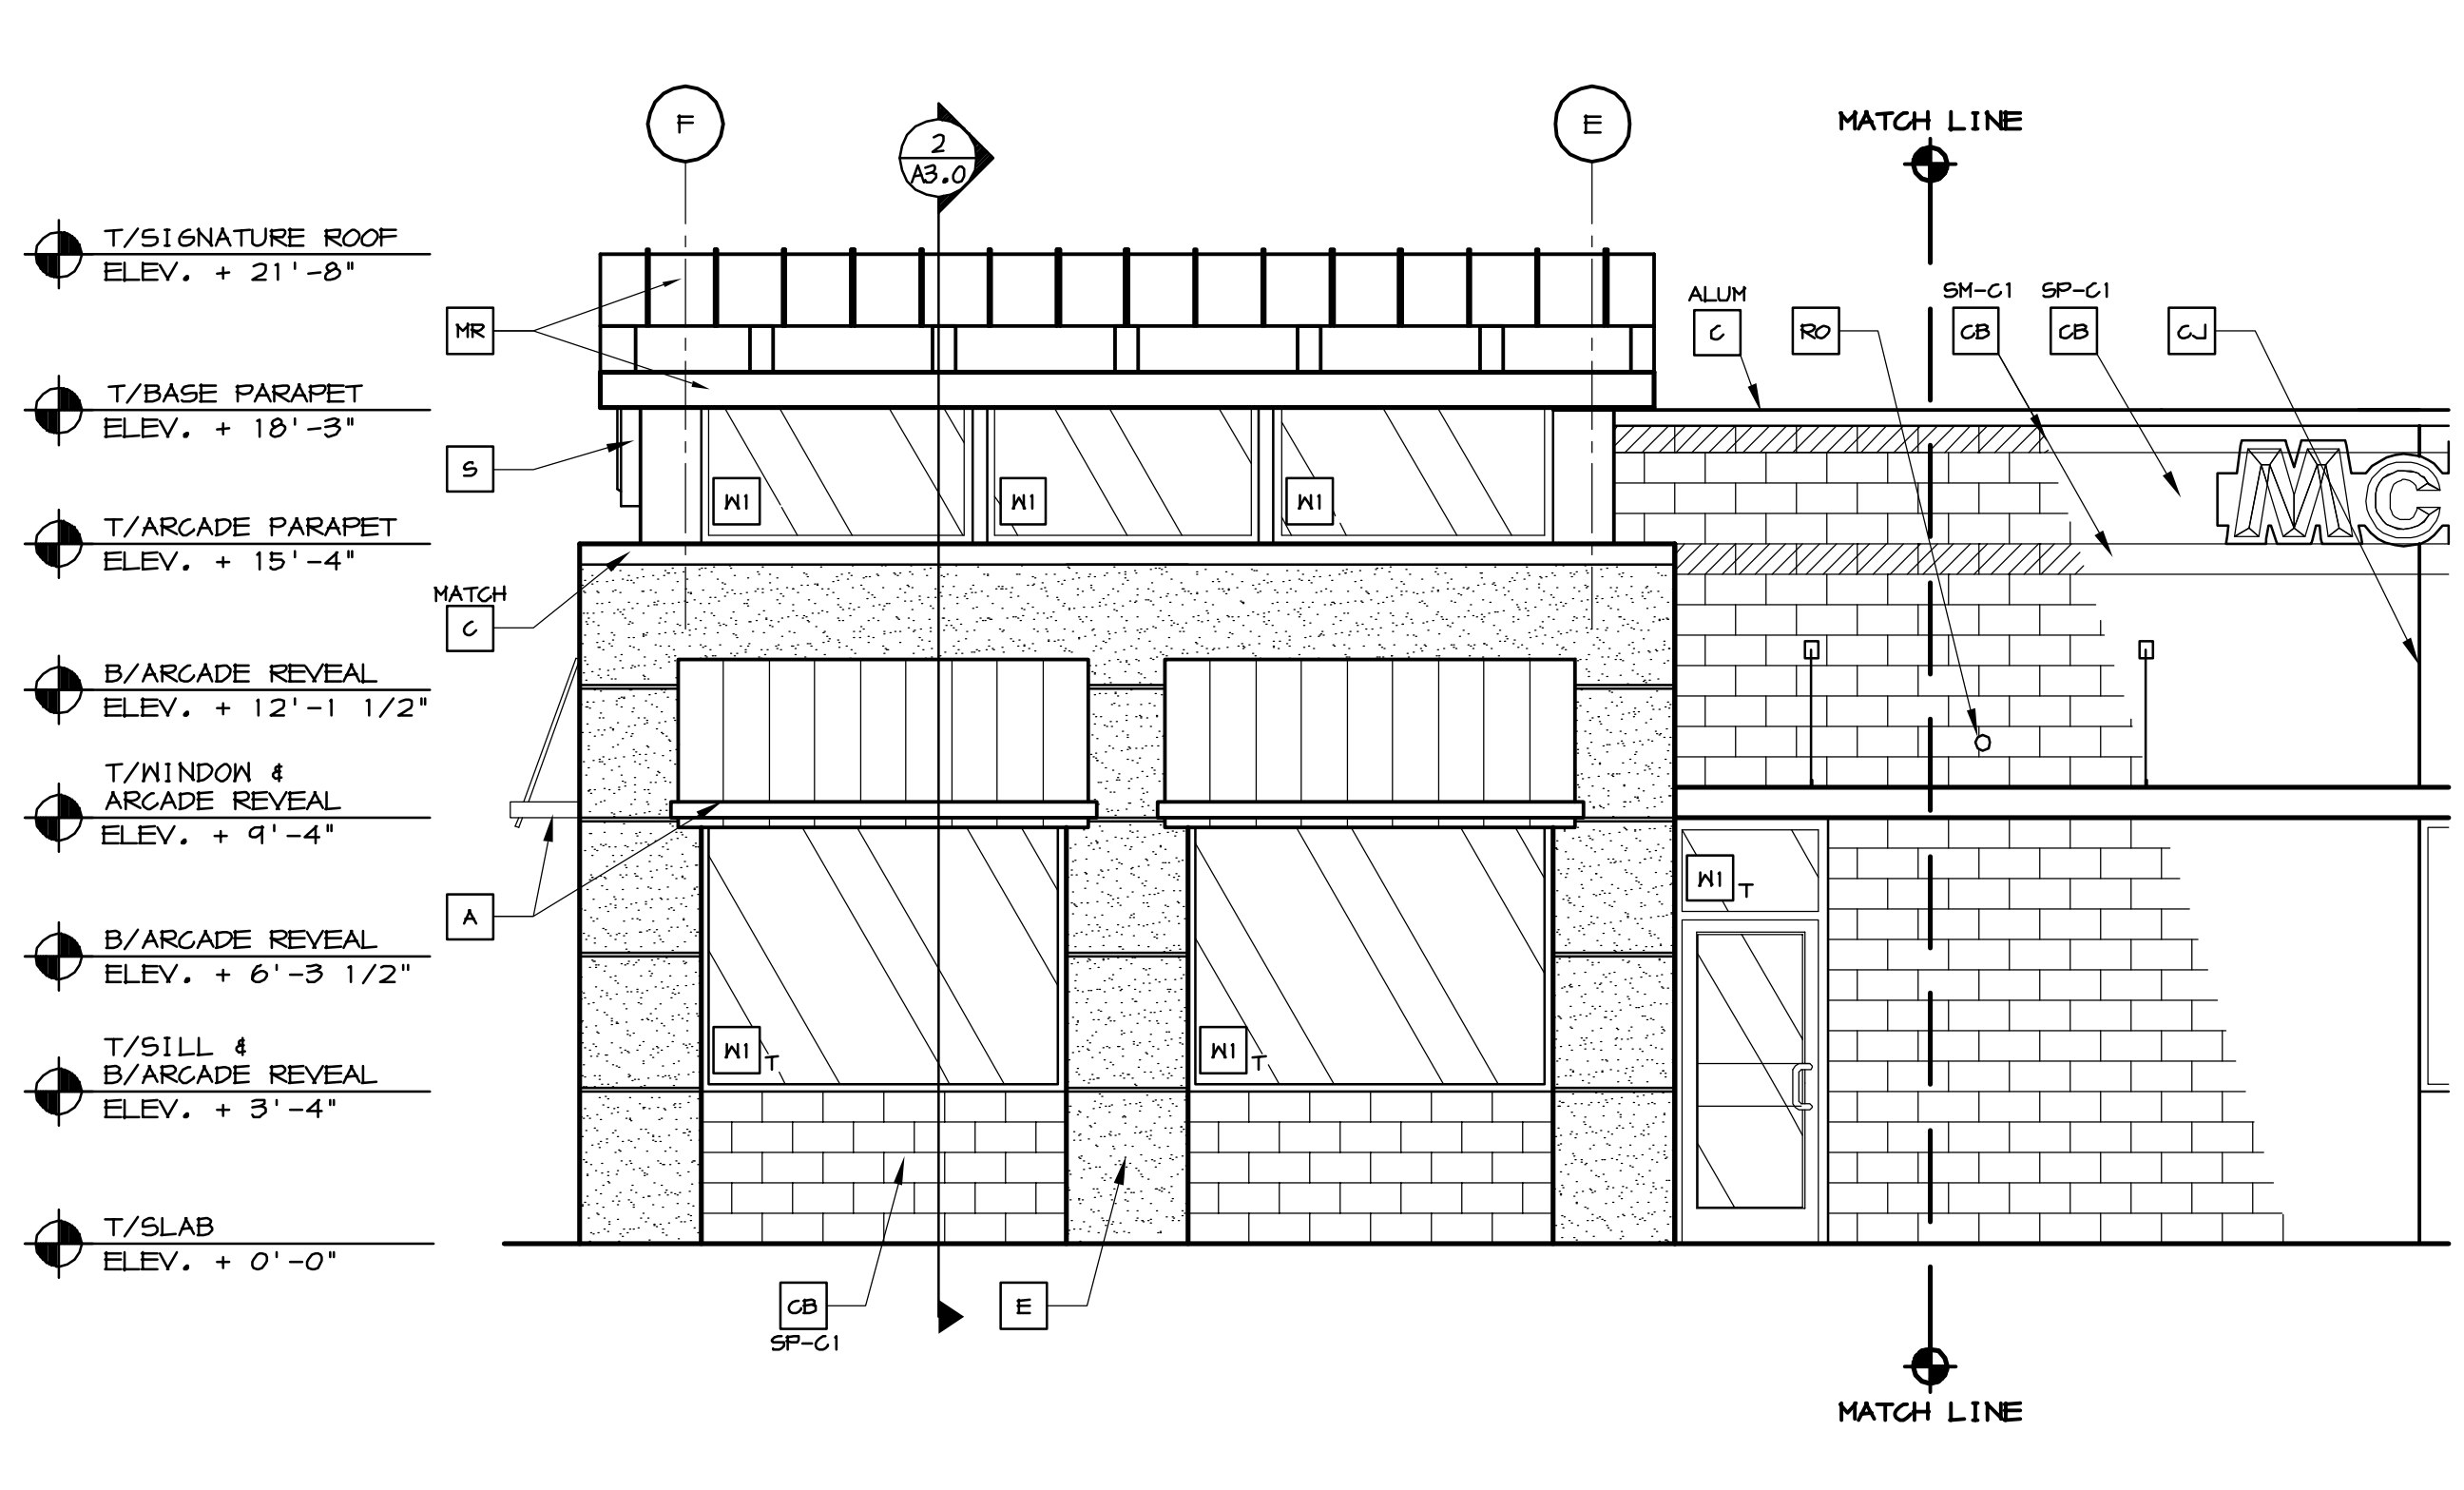

2 NON DRIVE-THRU ELEVATION  
A2.0 1/4" = 1'-0"  
(SEE ELEVATION 1/A2.1 FOR CONTINUATION OF ELEVATION)

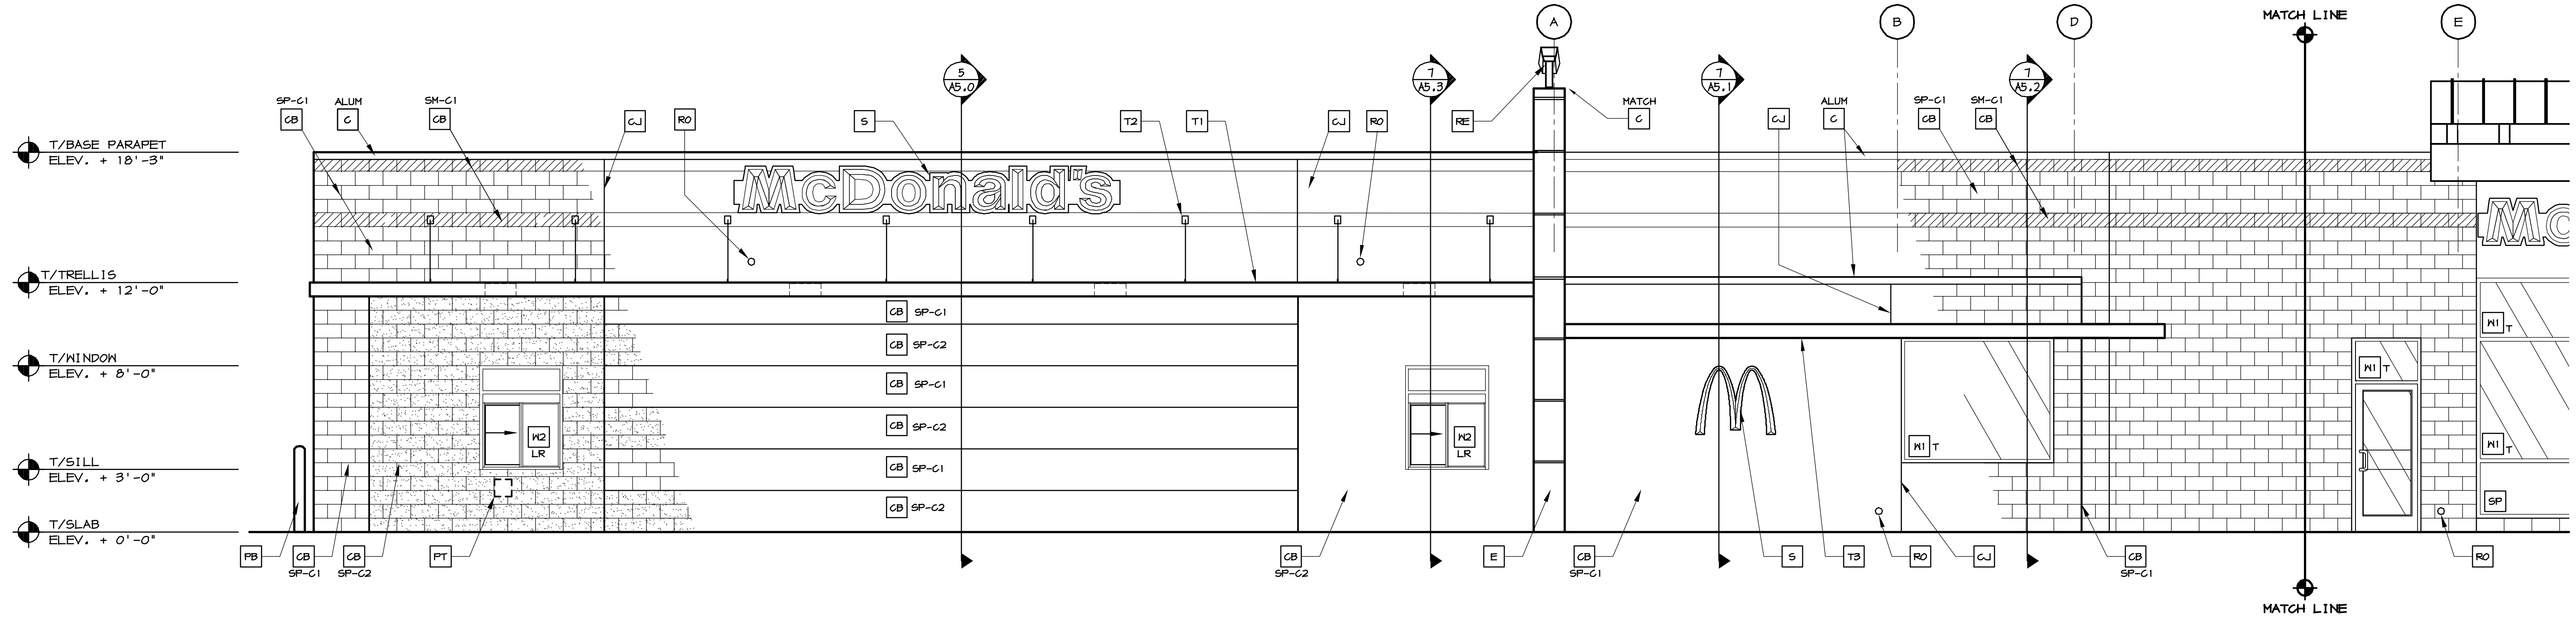

3 DRIVE-THRU ELEVATION  
A2.0 1/4" = 1'-0"  
(SEE ELEVATION 2/A2.1 FOR CONTINUATION OF ELEVATION)

**SIGNAGE SUPPORT NOTE:**  
UNIBODY FASCIA SIGN WALL SUPPORTS TO BE VERIFIED WITH McDONALD'S AREA CONSTRUCTION MANAGER AND COORDINATED WITH SIGN MANUFACTURER.

**KEY NOTES:**

- A METAL AWNINGS - UNDER SEPARATE PERMIT. COLOR TO BE ALTERNATING STRIPES TO MATCH PANTONE 106U AND 104C
- AP ALUMINUM PANEL - COLOR TO MATCH WINDOW FRAMES
- CB CONCRETE BLOCK
- SP-C1 COLOR: C1 = 4416 BY NORTHFIELD OR EQUAL C2 = A-1 BY NORTHFIELD OR EQUAL TYPE: SP = SPLIT FACE; SM = SMOOTH
- C METAL COPING - COLOR = ALUMINUM
- CONTROL JOINT, SEE DETAIL T/A4.1
- D HOLLOW METAL DOOR - PAINT TO MATCH COLOR OF SURROUNDING MATERIAL
- E EXT. INSULATION FINISH SYSTEM (E.I.F.S.) COLOR = DOVE WHITE
- FB CO2 FILL BOX (EOPM SCHEDULE ITEM 44.00) CO2
- OPTIONAL BULK OIL FILL BOX (EOPM SCHEDULE ITEM 700.18) - CONFIRM USE WITH MCD PROJECT MANAGER
- L LIGHT FIXTURE (WALL SCNGE) - SEE ELECTRICAL
- ML METAL LETTERING - BY OTHERS
- MR METAL ROOF - STANDING SEAM W/ALUMINUM FINISH FASCIA TRIM AND TRELLIS, COLOR TO BE "YELLOW" - PANTONE COLOR #104U"
- PB PIPE BOLLARD
- PT PASS-THRU COIN COLLECTOR - OPTIONAL (R#4C)
- RE ROOF GAP ELEMENT BY OTHERS
- RD ROOF DRAIN OVERFLOW PIPE PAINT TO MATCH SURROUNDING MATERIAL
- S McDONALD'S SIGNAGE BY OTHERS - UNDER SEPARATE PERMIT. SEE SIGNAGE SUPPORT NOTE ON THIS SHEET.
- SP SPANDREL PANEL SET IN AN EXTERIOR WINDOW ASSEMBLY - SEE ASSEMBLY NOTES ON SHEET AS.0, COLOR TO MATCH WINDOW FRAMES
- T1 ALUMINUM TRELLIS
- T2 TRELLIS TIE-BACK
- T3 TRELLIS SYSTEM 2X8 WALL FASCIA
- NI EXTERIOR WINDOW ASSEMBLY - SEE ASSEMBLY NOTES ON SHEET AS.0
- T = TEMPERED GLASS
- DRIVE-THRU WINDOW BY READY ACCESS - CONFIRM MODEL, OPTIONS, AND SIZE WITH MCD PROJECT MANAGER
- TRANSOM (SHOWN): AIR CURTAIN: FLYFAN/TRANSOM # 432 50 IN MAX SERVICE OPENING (WHERE REGD BY CODE)
- SLIDE DIRECTION: RL = RIGHT TO LEFT LR = LEFT TO RIGHT

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PREPARED BY:	McDonald's USA, LLC	
DRAWN BY:	6-JULLOA	
BTD ISSUE DATE:	MAR 2006	
REVIEWED BY:	RDG TEAH	
DATE ISSUED:		
TITLE:	2006 STANDARD BUILDING 4587FP-MASONRY/STEEL BLDG.	
DESCRIPTION:	6" CMU BEARING WALLS STEEL TRUSS ROOF FRAMING	
SHEET NO.:	00-0000.00.0	
ELEVATIONS:	A2.0	
REV	DATE	DESCRIPTION
BY		